CONTRACT DRAWINGS EAST SWARTOUT STORMWATER IMPROVEMENTS CLEARWATER RIVER WATERSHED DISTRICT


DECEMBER 2014



PROJECT LOCATION MAP



ENLARGED PROJECT LOCATION MAP

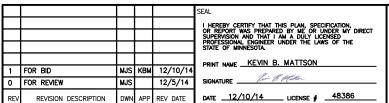



EAST SWARTOUT
STORMWATER IMPROVEMENTS CLEARWATER RIVER

WATERSHED DISTRICT MJS RAK

TITLE SHEET APP'D DWG DATE DEC 2014 KBM SCALE AS SHOWN

G-101

G-101 TITLE SHEET

INDEX OF SHEETS

EXISTING CONDITIONS & REMOVAL PLAN

C-201 SWPPP PLAN


C-202 EROSION & SEDIMENT CONTROL PLAN

GRADING PLAN C-301

DETAILS C-801

C-802 DETAILS

C-803 DETAILS

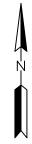

WARNING:

THE CONTRACTOR SHALL BE RESPONSIBLE FOR CALLING FOR LOCATIONS OF ALL EXISTING UTILITIES. THEY SHALL COOPERATE WITH ALL UTILITY COMPANIES IN MAINTAINING THEIR SERVICE AND/OR RELOCATION OF LINES.

THE CONTRACTOR SHALL CONTACT GOPHER STATE ONE CALL AT 651-454-0002 AT LEAST 48 HOURS IN ADVANCE FOR THE LOCATIONS OF ALL UNDERGROUND WIRES, CABLES, CONDUITS, PIPES, MANHOLES, VALVES OR OTHER BURIED STRUCTURES BEFORE DIGGING. THE CONTRACTOR SHALL REPAIR OR REPLACE THE ABOVE WHEN DAMAGED DURING CONSTRUCTION AT NO COST TO THE OWNER.

CALL BEFORE YOU DIG GOPHER STATE ONE CALL TWIN CITY AREA: 651-454-0002 TOLL FREE 1-800-252-1166

0002-205



- SALVAGE AND REINSTALL ALL SIGNS AS DIRECTED BY ENGINEER (INCIDENTAL).
 ALL QUANTITIES ARE APPROXIMATE AND MAY VARY TO ALLOW COMPLETION OF WORK.
 PRIVATE UTILITIES ARE SHOWN IN GENERAL LOCATIONS. CONTRACTOR TO COORDINATE WITH
 PRIVATE UTILITY OWNERS PER GOPHER STATE ONE REQUIREMENTS.
 NOTIFY ENGINEER IMMEDIATELY OF ALL EXISTING SEWER AND WATER SERVICE CONFLICTS.
 CONTRACTOR TO STRIP AND SALVAGE EXISTING TOPSOIL.
 REVIEW ALL TREE REMOVALS WITH ENGINEER.

| | | | | | I HEREBY CERTIFY THAT THIS PLAN, SPECIFICATION, OR REPORT WAS PREPARED BY ME OR UNDER MY DIRECT SUPERVISION AND THAT I AM A DULY LICENSED PROFESSIONAL ENGINEER UNDER THE LAWS OF THE STATE OF MINNESOTA. | | | | |
|-----|----------------------|------|--------|----------|---|--|--|--|--|
| | SAD DID | 1110 | 1/5) (| 40/40/44 | PRINT NAME KEVIN B. MATTSON | | | | |
| 1 | FOR BID | MJ2 | KBM | 12/10/14 | 1. 11 2.1. | | | | |
| 0 | FOR REVIEW | MJS | | 12/5/14 | SIGNATURE for M. Marken | | | | |
| REV | REVISION DESCRIPTION | DWN | APP | REV DATE | DATE 12/10/14 LICENSE # 48386 | | | | |

EAST SWARTOUT
STORMWATER IMPROVEMENTS

CLEARWATER RIVER WATERSHED DISTRICT

EXISTING CONDITIONS
& REMOVAL PLAN

APP'D DWG DATE DEC 2014
SCALE AS SHOWN DWN BY CHK'D RAK C-101 0002-205

Cumulative Impervious Surface Existing impervious surface - 0.00 acres Proposed impervious surface - 0.00 acres

Total Area Disturbed by Construction - 0.75 acres

Construction Dates: February 2015 - December 2015

Party Responsible for Long Term Operation and Maintenance of the Site - OWNER

Clearwater River Watershed District

75 Elm St E, Box 481

Annandale, MN 55301 320-274-3935

Party Responsible for Implementation of the SWPPP - CONTRACTOR (TBD)

EROSION AND SEDIMENT CONTROL PRACTICES

Prior to any site disturbance the erosion prevention measures, including rock construction entrances and silt fence, will be installed at the site as shown on Sheets C-202.

All exposed soil areas within 7 days or as soon as possible must have temporary erosion protection (slash mulch, erosion control blanket, seed) or permanent cover year round.

CONTRACTOR shall implement appropriate construction phasing, vegetative buffer strips, horizontal slope grading, and other construction practices that minimize erosion when practical.

The normal wetted perimeter of any temporary or permanent drainage ditch that drains water from a construction site, or diverts water around a site, must be stabilized within 200 lineal feet from the property edge, or from the point of discharge to any surface water. Stabilization must be completed within 24 hours of connecting to a surface water. Pipe outlets must be provided with temporary or permanent energy dissipation within 24 hours of connection to a surface water.

Sediment control practices must minimize sediment from entering surface waters, including curb and gutter systems and storm sewer inlets. The following measures will be taken as sediment control practices in order to minimize sediments from entering surface waters:

- 1. Installation of sediment control practices on all down gradient perimeters prior to land disturbing activities.
- 2. Minimize vehicle tracking by use of the rock construction entrances.
- 3. Street sweeping of tracked sediment when necessary.

Dewatering is anticipated for the excavation work of this project. Discharge filtration should be incorporated into the dewatering activities. Energy dissipation shall be provided at all discharge points to prevent scour.

Because the project is less than 5 acres, temporary sedimentation basins are not required.

Record Retention

The SWPPP, all changes to it, and inspection and maintenance records must be kept on-site during construction. The OWNER must retain a copy of the SWPPP along with the following records for three (3) years after submittal of the Notice of Termination.

- 1. Any other permits required for the project;
- 2. Records of all inspection and maintenance conducted during construction;
- 3. All permanent operations and maintenance agreements that have been implemented, including all right of way, contract, covenants and other binding requirements regarding perpetual maintenance; and
- 4. All required calculations for design of the temporary and permanent stormwater management systems.

Pollution Prevention Measures

Solid Waste

Solid waste, including but not limited to, collected asphalt and concrete millings, floating debris, paper, plastic, fabric, construction and demolition debris and other waste must be disposed of properly and must comply with MPCA disposal requirements.

Hazardous Materials

Hazardous materials, including but not limited to oil, gasoline, paint and any hazardous substance must be properly stored including secondary containments, to prevent spills, leaks or other discharge. Restricted access to storage areas must be provided to prevent vandalism. Storage and disposal of hazardous waste must be in compliance with MCPA regulations.

Washing of Construction Vehicles

External washing of trucks and other construction vehicles must be limited to a defined area of the site. Runoff must be contained and waste properly disposed of. No engine degreasing is allowed on site.

Concrete Washout Area

Concrete washout is not anticipated for this project.

Inspections

The inspection log will be completed by the CONTRACTOR for the construction site. Inspections at the site will be completed as follows:

- Once every seven (7) days during active construction and,
- Within 24 hours after a rainfall event greater than 0.5 inches in 24 hours.

The individual performing inspections must be trained as required by part IV.E of the Permit. CONTRACTOR to provide OWNER with proof of training. Inspections must include stabilized areas, erosion prevention and sediment control BMPs, and infiltration areas. Corrective actions must be identified and date of correction must be noted as identified in Section IV.E. of the Permit.

Final Stabilization

All areas disturbed by construction will receive seed and mulch or sod according to the plans and specifications and within the specified vegetative time schedule. Final stabilization will occur when the site has a uniform vegetative cover with a density of 70% over the entire disturbed area. All temporary synthetic erosion prevention and sediment control BMPs (such as silt fence) must be removed as part of the site final stabilization. All sediment must be cleaned out of conveyances and temporary sedimentation basins if applicable.

Notice of Termination (NOT) must be submitted within 30 days of final stabilization.

IMPAIRED WATERS, SPECIAL WATERS, AND WETLANDS

This Project is not located within 1 mile of a special water.


This Project is located within 1 mile of an impaired waters (Figure 4 this sheet):

Albion Lake impaired for Nutrients Swartout Lake impaired for Nutrients

Because of the proximity of the project to an impaired water during construction:

- 1. All exposed soil areas must be stabilized as soon as possible to limit soil erosion but in no case later than seven (7) days after the construction activity in that portion of the site has temporarily or permanently ceased.
- 2. Temporary sediment basins are required to handle runoff for common drainage locations that serve an area with 5 or more acres disturbed at one time.

This Project will temporarily impact wetlands. A wetland delineation has been performed and wetland permits have been obtained.

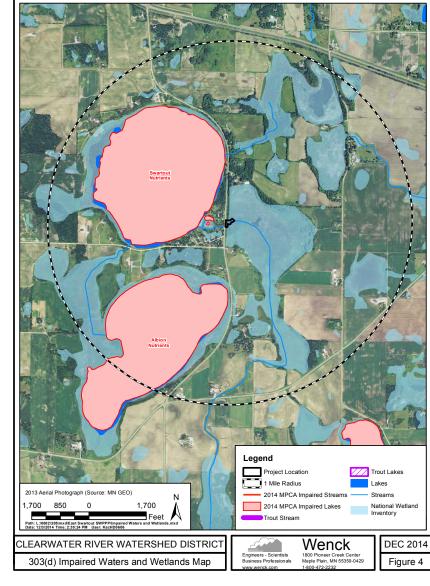


CERTIFICATION

In accordance with Part III.A.2 of the General Permit Authorization to Discharge Stormwater Associated with Construction Activity under the NPDES, the preparer of this document was trained under the University of Minnesota Erosion and Sediment Control Certification Program. Mr. Louis Sigtermans' certification in Design of SWPPP is valid through May 31, 2017.

University of Minnesota

Louis H Sigtermans Saint Paul, MN

Design of Construction SWPPP (May 31, 2017)

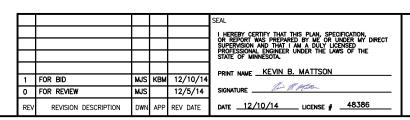



SHEET TITLE

SHEET TITLE

SWPPP


CLEARWATER RIVER WATERSHED DISTRICT


DWN BY CHK'D APP'D DWG DATE DEC 2014

MJS RAK KBM SCALE AS SHOWN

PROJECT NO. SHEET NO. REV NO.

0002–205 C-201 1

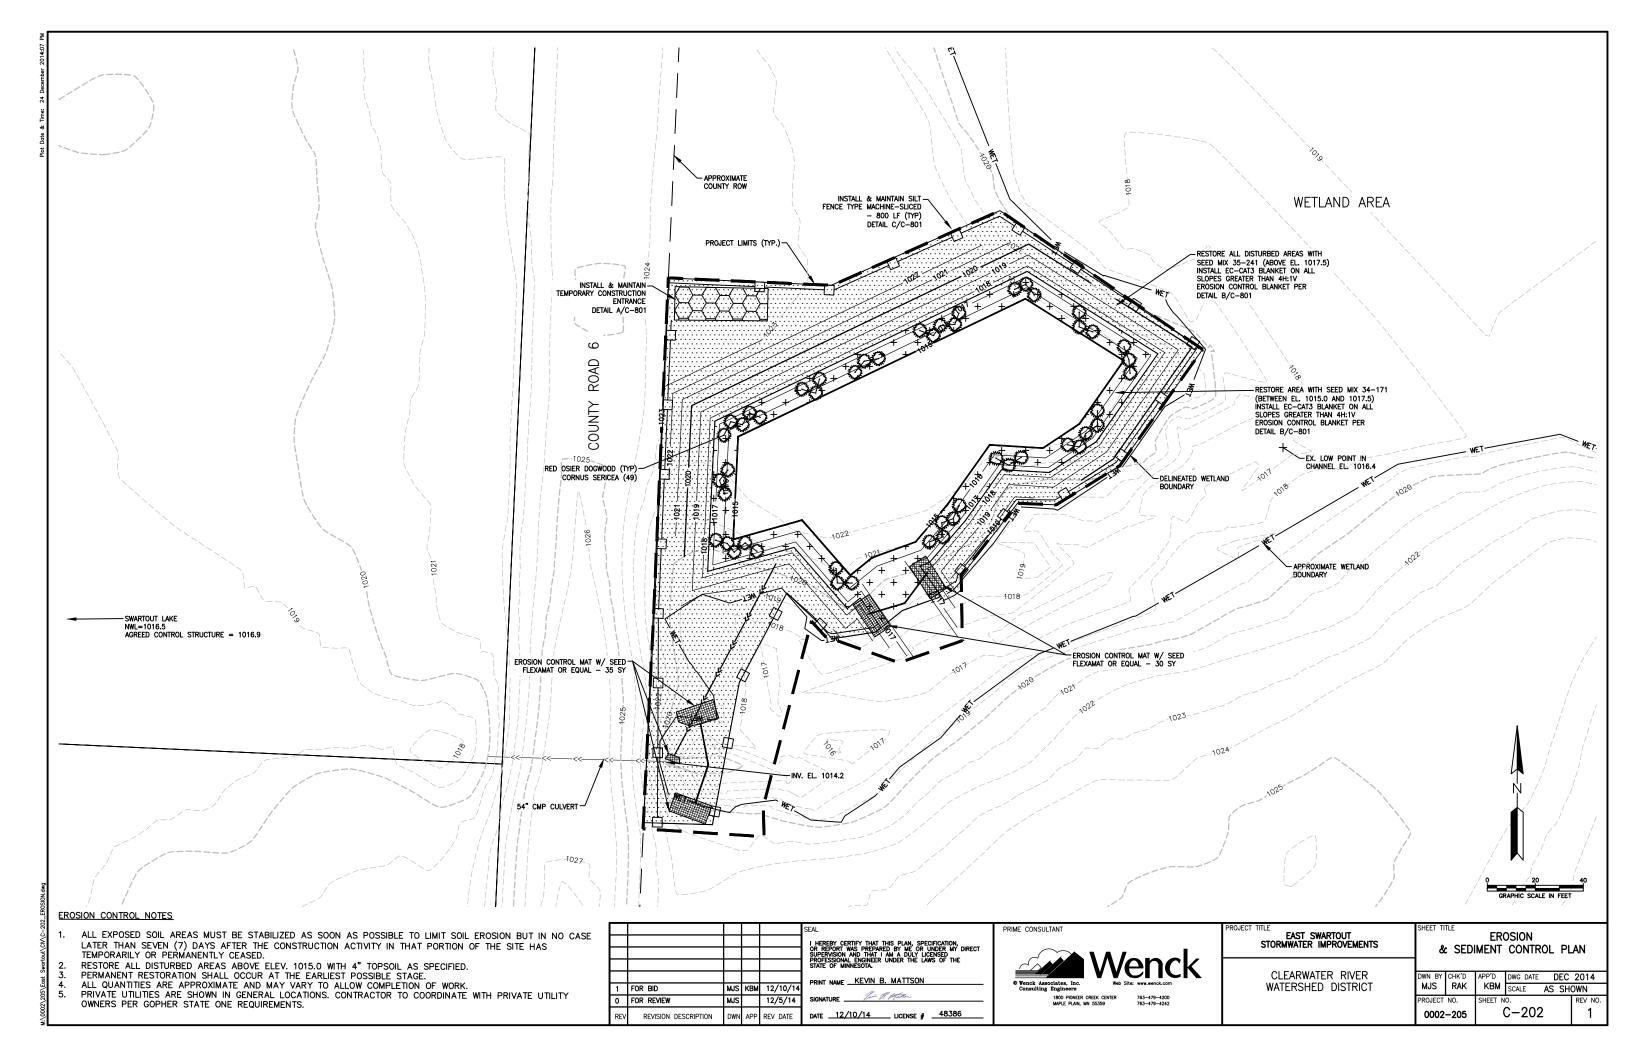

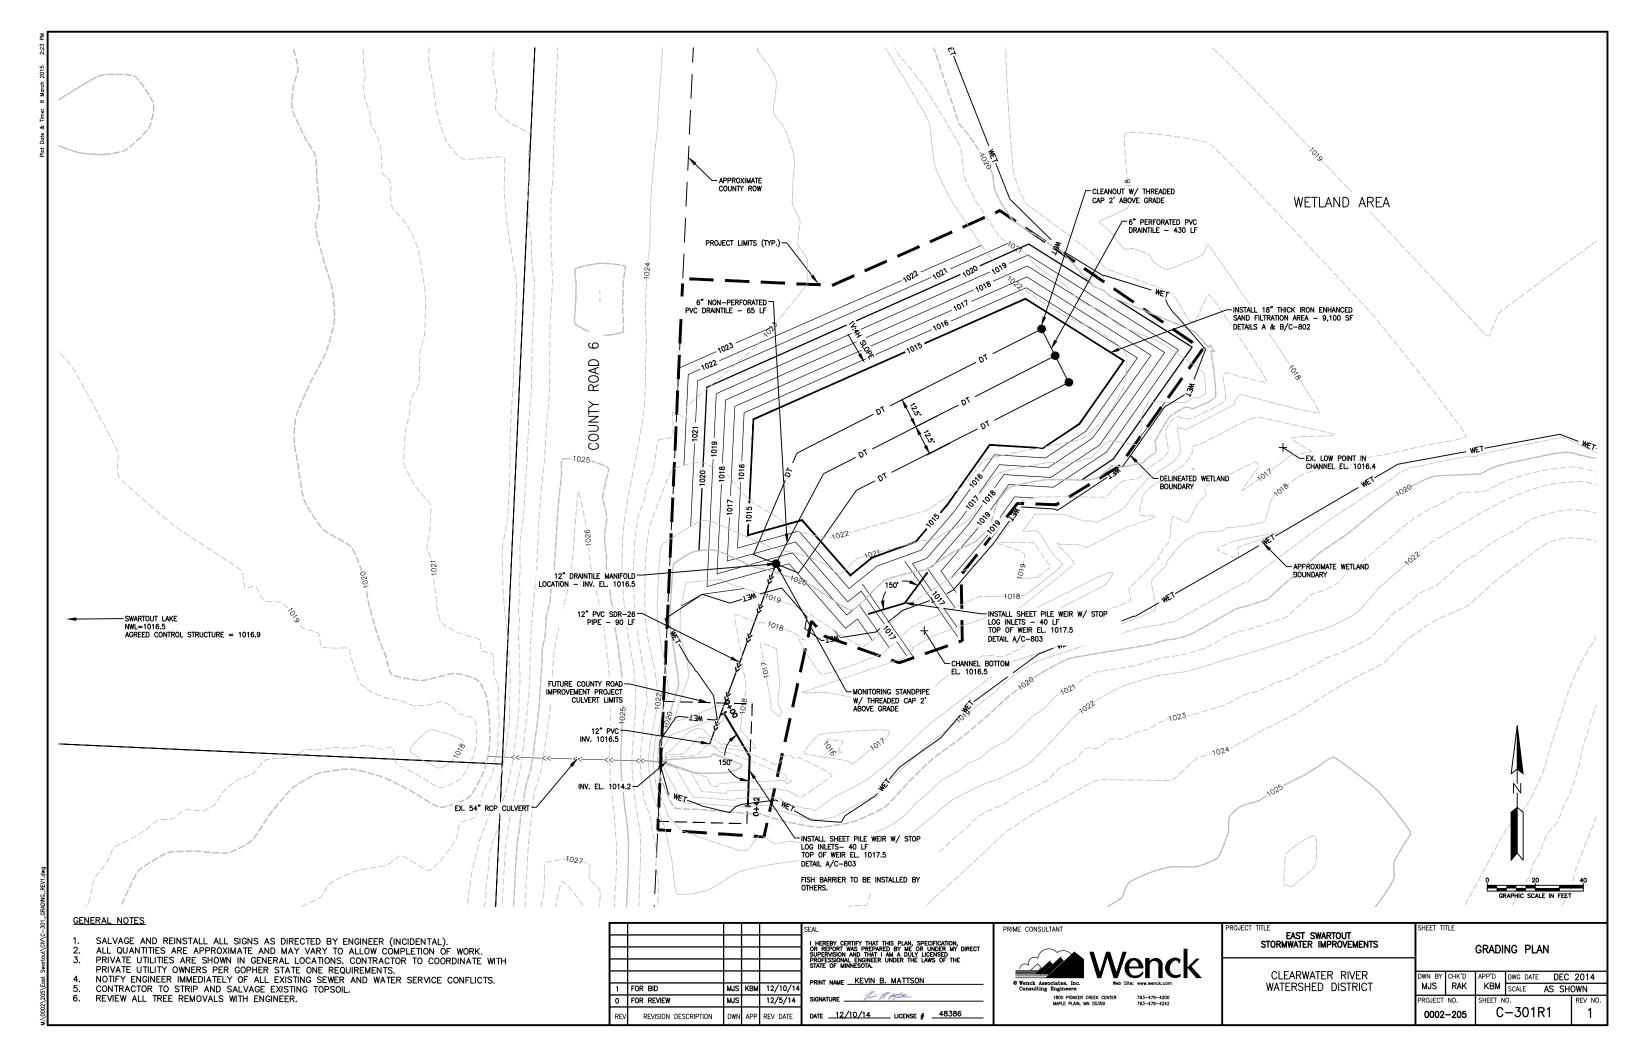

NOTE: FILTER FABRIC SHALL BE PLACED UNDER ROCK TO STOP MUD MIGRATION THROUGH ROCK.

A TEMPORARY CONSTRUCTION ENTRANCE DETAIL

ANCHOR TRENCH (SEE DETAIL AND NOTES BELOW)

OVERLAP END JOINTS MINIMUM OF 6" AND STAPLE OVERLAP AT 1.5" INTERVALS.

MINIMUM OF 3 U-SHAPED 8", 11 GAUGE METAL STAPLES PER SQUARE YARD (THIS MAY VARY AS DIRECTED BY THE ENGINEER).


OVERLAP END JOINTS MINIMUM OF 6" AND STAPLE OVERLAP AT 1.5" INTERVALS.

OVERLAP LONGITUDINAL JOINTS MINIMUM OF 6"

OVERLAP END JOINTS MINIMUM OF 6"

OVERLAP E

R EROSION CONTROL BLANKET DETAIL

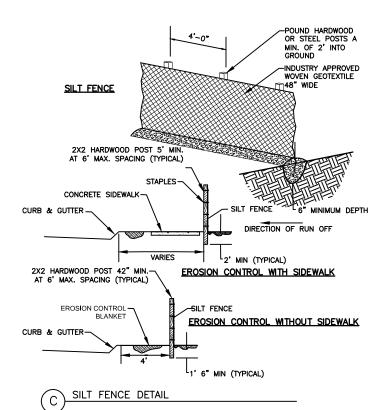

SEAL

I HEREBY CERTIFY THAT THIS PLAN, SPECIFICATION, OR REPORT WAS PREPARED BY ME OR UNDER MY DIRECT SUPERVISION AND THAT I AM A DULY LICENSED PROFESSIONAL ENGINEER UNDER THE LAWS OF THE STATE OF MININESOTA.

1 FOR BID

MJS KBM 12/10/14

PRINT NAME KEVIN B. MATTSON

SIGNATURE

SIGNATURE

AND MATTSON

SIGNATURE

AND MATTSON

SIGNATURE

AND MATTSON

DATE 12/10/14 LICENSE # 48386


Venck Associates, Inc.
Consulting Engineers
1800 PIONEER CREEK CENTER
703-478-4200

EAST SWARTOUT
STORMWATER IMPROVEMENTS

CLEARWATER RIVER
WATERSHED DISTRICT

MJS RAK
PROJECT NO.

SHEET TITLE

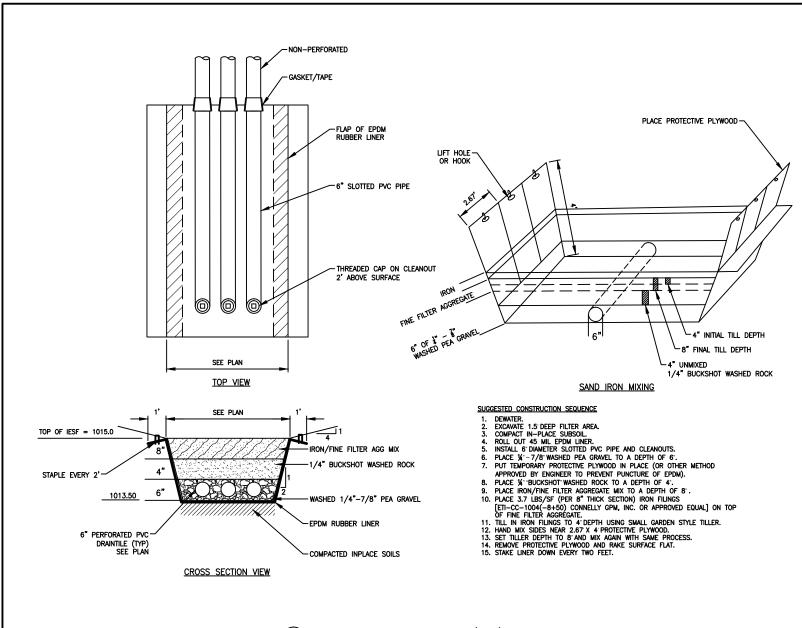

- CLEANOUT W/ THREADED CAP 2' ABOVE GRADE - IRON ENHANCED SAND FILTER AREA EL. 1015.0 (TOP) MONITORING STANDPIPE W/THREADED CAP 2' ABOVE GRADE INV. 1016.5 — 6" NON-PERFORATED -PVC DRAINTILE 12" PVC \ SDR-26 PIPE INV. 1013.50 (BOTTOM) 12" PVC -INV. 1016.5 -6" PERFORATED PVC DRAINTILE (TYP) INV. 1013.50 SDR-26 PIPE NON-PERFORATED PVC DRAINTILE

(B) IRON ENHANCED SAND FILTER (IESF) DRAINTILE SCHEMATIC

(A) IRON ENHANCED SAND FILTER (IESF) TYPICAL SECTION

SEAL

I HEREBY CERTIFY THAT THIS PLAN. SPECIFICATION, OR REPORT WAS PREPARED BY HE OR UNDER MY DIRECT SUPPRISONAL ENGINEER UNDER THE LAWS OF THE STATE OF MINNESOTA.

1 FOR BID

MJS KBM 12/10/14

PRINT NAME KEVIN B. MATTSON

PRINT NAME KEVIN B. MATTSON

SIGNATURE

REV REVISION DESCRIPTION

MBS KBM X2/8/x/XX

REV REVISION DESCRIPTION

MP REV DATE

DATE 12/10/14 LICENSE 4 48386


• Venck Associates, Inc.
Consulting Engineers

Web Site: www.wenck.com
WHOE PARN, UNI 53359

763-479-4202
763-479-4242

CLEARWATER RIVER
WATERSHED DISTRICT


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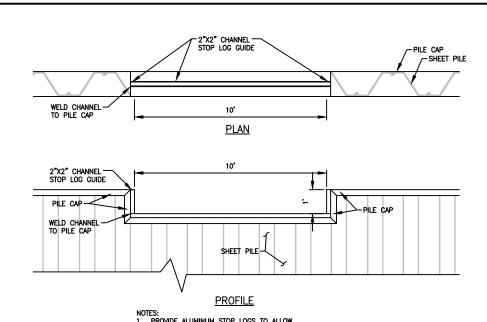


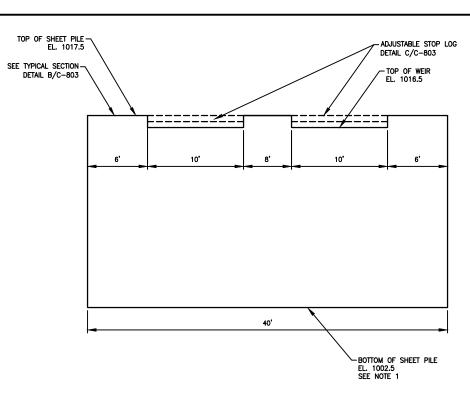NOTES:

1. BOTTOM OF SHEET PILE SHALL BE 15 FEET BELOW PROPOSED GRADE OR TO REFUSAL, WHICHEVER COMES FIRST

WEIR DETAILS



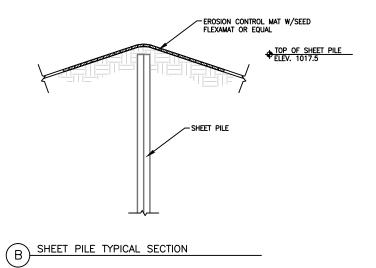


NOTES:

1. PROVIDE ALUMINUM STOP LOGS TO ALLOW ADJUSTMENT OF WEIR HEIGHT.

2. EACH STOP LOG SHALL BE 6 INCHES TALL, WITH LOCKING MECHANISM TO PREVENT THEFT AND VANDALISM.

ADJUSTABLE STOP LOG DETAIL

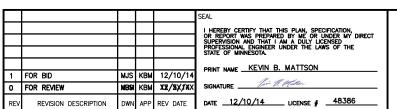



| STORMWATER IMPROVEMENTS | DETAILS | | | | | | |
|-------------------------|-------------|-------|-----------|----------|-------|---------|--|
| CLEARWATER RIVER | DWN BY | CHK'D | APP'D | DWG DATE | DEC | 2014 | |
| WATERSHED DISTRICT | MJS | RAK | КВМ | SCALE | AS SH | | |
| | PROJECT NO. | | SHEET NO. | | | REV NO. | |
| | 0002 | -205 | C-803 | | | 1 | |

EAST SWARTOUT

SHEET TITLE